


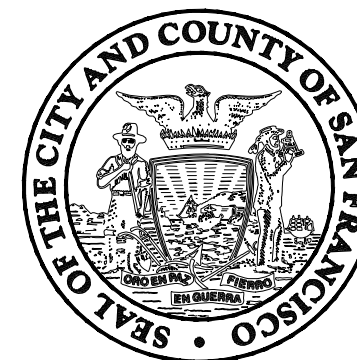

HETCH HETCHY  
WATER SYSTEM  
IMPROVEMENT  
PROGRAM

CITY AND COUNTY OF SAN FRANCISCO  
PUBLIC UTILITIES COMMISSION  
SAN FRANCISCO WATER DEPARTMENT



CONTRACT NO. WD-2651  
HABITAT RESERVE PROGRAM  
UPPER SAN MATEO CREEK MITIGATION  
VOLUME 1 OF 1  
OCTOBER 2010


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CONSTRUCTION

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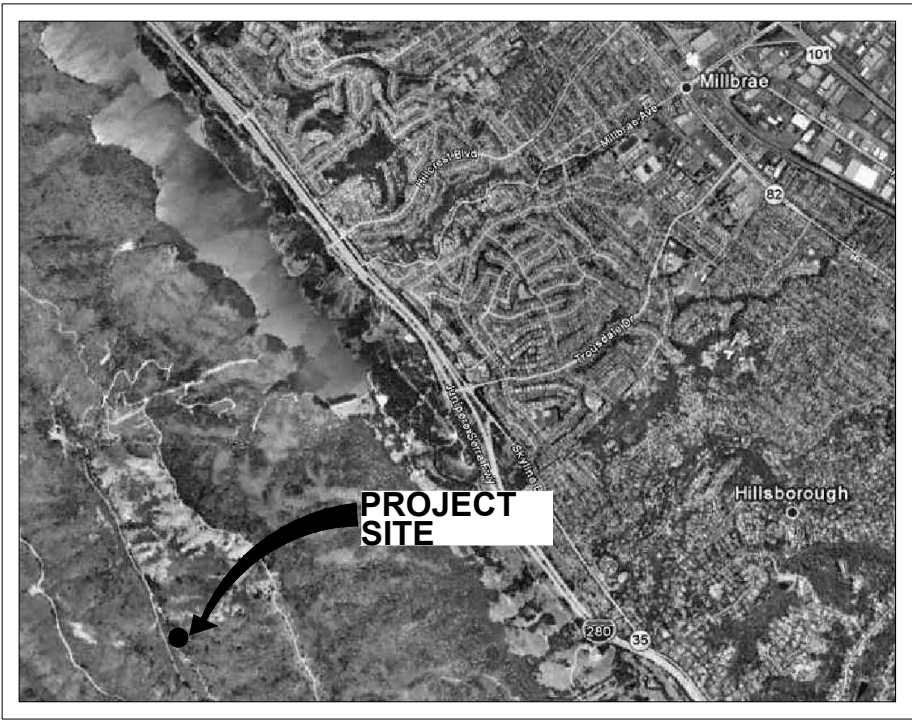
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SFPUC.

AT THE TIME OF THE BID OPENING, THE CONTRACTOR SHALL POSSESS A  
VALID CALIFORNIA CLASS A, GENERAL ENGINEERING CONTRACTOR'S LICENSE.

CITY AND COUNTY OF SAN FRANCISCO  
PUBLIC UTILITIES COMMISSION  
HABITAT RESERVE PROGRAM  
UPPER SAN MATEO CREEK SITE  
CONTRACT NO. WD-2651

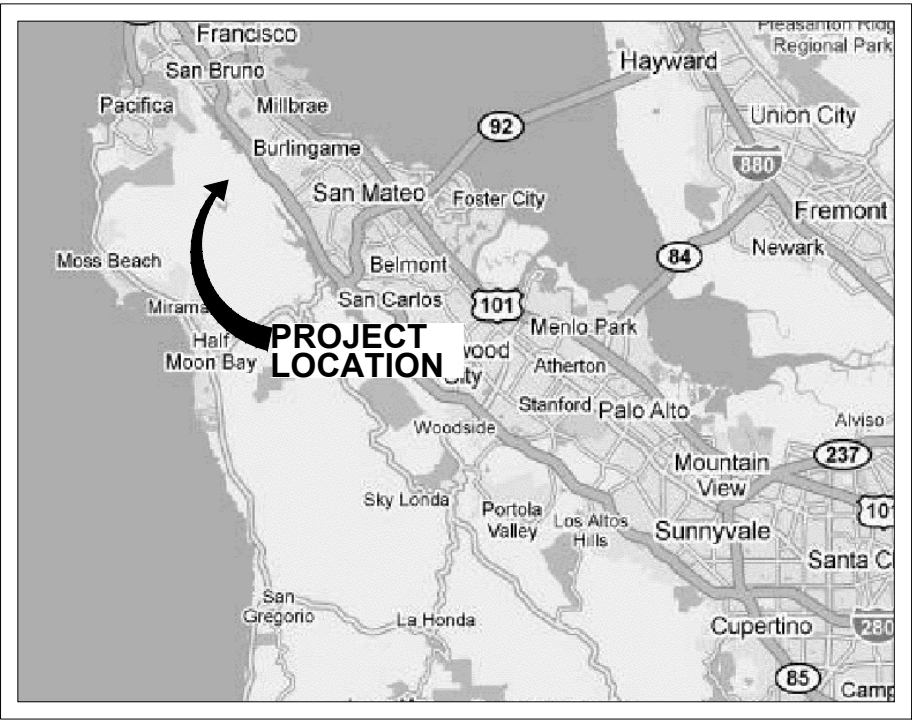

VICINITY MAP  
NO SCALE



LOCATION MAP  
NO SCALE

SHEET NUMBER	DRAWING NUMBER	DESCRIPTION OF DRAWING
1	G-0	COVER SHEET
2	G-1	TITLE SHEET, LOCATIONS AND VICINITY MAPS, DRAWING INDEX
3	G-2	ABBREVIATIONS, LEGEND, GENERAL NOTES, ACCESS ROAD
4	C-1	ALIGNMENT AND SURVEY CONTROL PLAN
5	C-2	EXISTING CONDITION AND DEMOLITION PLAN
6	C-3	WETLAND GRADING PLAN
7	C-4	WETLAND SECTIONS
8	C-5	WETLAND SECTIONS
9	C-6	CONSTRUCTION DETAILS
10	L-1	PLANTING PLAN

CONTRACT NO. WD-2651

CITY AND COUNTY OF SAN FRANCISCO  
PUBLIC UTILITIES COMMISSION  
INFRASTRUCTURE DIVISION  
ENGINEERING MANAGEMENT BUREAU

UPPER SAN MATEO CREEK

TITLE SHEET, LOCATIONS AND  
VICINITY MAPS, DRAWING INDEX

CHECKED / APPROVED	DRAWN	SCALE AS SHOWN
SECTION MANAGER	DESIGNED	DATE

APPROVED	APPROVED
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MANAGER, ENGINEERING MANAGEMENT BUREAU	MANAGER, NATURAL RESOURCES DIVISION
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SHEET	PLAN NO.	DRAWING NO.	REVISION NO.
2 of 10		G-1	

**WINZLER & KELLY**

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PROJECT ENGINEER	CQ	DRAWN	CQ
PROJECT MANAGER	MS	DESIGNED	CQ
APPROVAL	MS	CHECKED	ABW

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NO.	DATE	DESCRIPTION	BY	APPR'D
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REVISIONS


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CONSTRUCTION

OCTOBER 29,  
2010

COORDINATE:  
NAD83  
ELEVATION  
DATUM:  
NAVD 1988



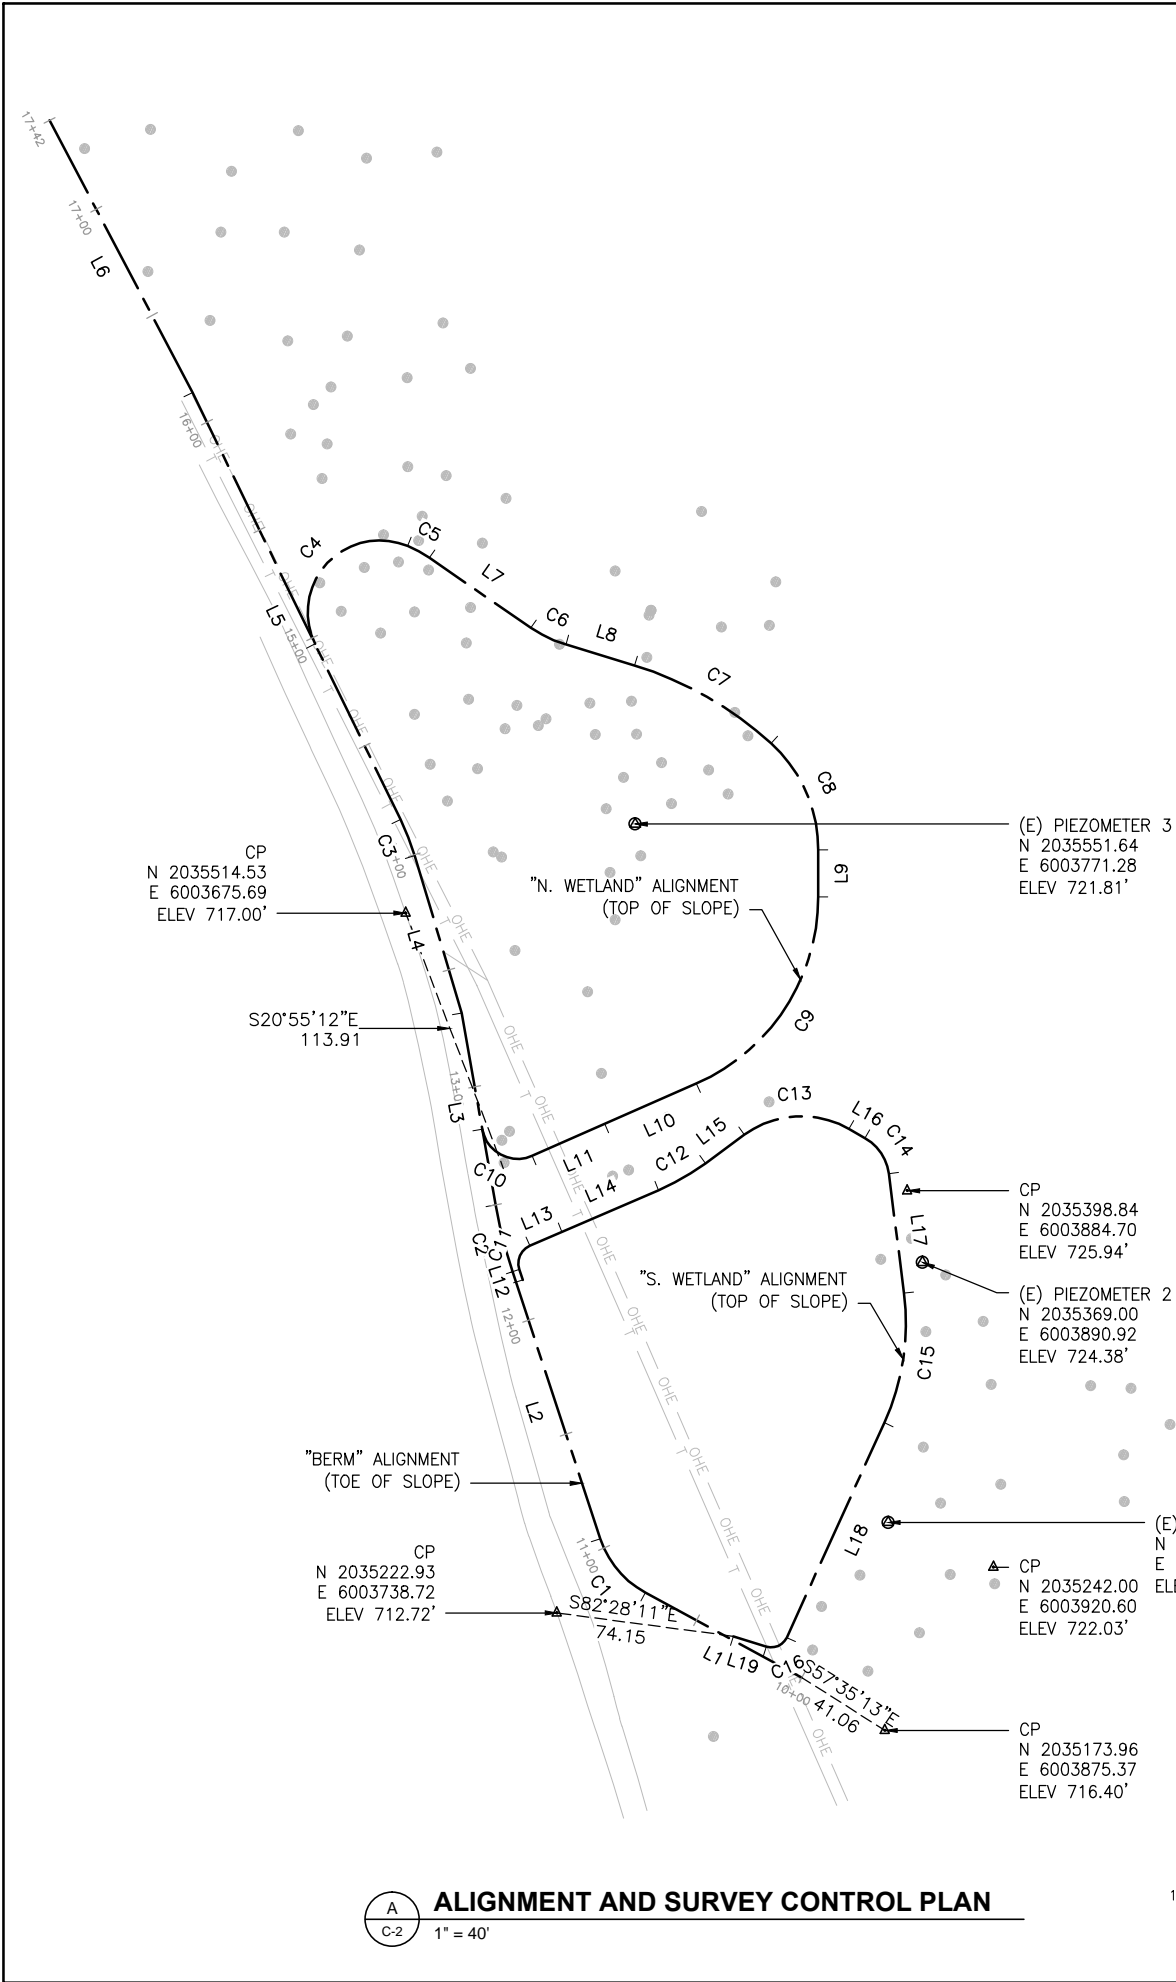

N. WETLAND						
SEGMENT	LENGTH	BEARING/Delta	RADIUS	TANGENT	START	END
C4	72.63	138°42'29"	30.00	79.62	STA: 0+00.00 N: 2035626.70 E: 6003637.86	STA: 0+72.63 N: 2035667.51 E: 6003676.42
C5	10.32	011°49'18"	50.00	5.18	STA: 0+72.63 N: 2035667.51 E: 6003676.42	STA: 0+82.94 N: 2035662.57 E: 6003685.46
L7	51.46	S55°26'49"E			STA: 0+82.94 N: 2035662.57 E: 6003685.46	STA: 1+34.40 N: 2035633.39 E: 6003727.84
C6	16.17	018°31'47"	50.00	8.16	STA: 1+34.40 N: 2035633.39 E: 6003727.84	STA: 1+50.57 N: 2035626.51 E: 6003742.40
L8	29.88	S72°56'07"E			STA: 1+50.57 N: 2035626.51 E: 6003742.40	STA: 1+80.46 N: 2035617.74 E: 6003770.96
C7	66.11	025°15'06"	150.00	33.60	STA: 1+80.46 N: 2035617.74 E: 6003770.96	STA: 2+46.57 N: 2035585.26 E: 6003827.93
C8	49.93	047°41'00"	60.00	26.52	STA: 2+46.57 N: 2035585.26 E: 6003827.93	STA: 2+96.50 N: 2035540.89 E: 6003847.54
L9	19.58	S00°00'00"E			STA: 2+96.50 N: 2035540.89 E: 6003847.54	STA: 3+16.08 N: 2035521.31 E: 6003847.54
C9	98.29	066°15'06"	85.00	55.47	STA: 3+16.08 N: 2035521.31 E: 6003847.54	STA: 4+14.37 N: 2035443.51 E: 6003796.77
L10	41.74	S66°15'06"W			STA: 4+14.37 N: 2035443.51 E: 6003796.77	STA: 4+56.11 N: 2035426.70 E: 6003758.56
L11	33.00	S66°15'06"W			STA: 4+56.11 N: 2035426.70 E: 6003758.56	STA: 4+89.11 N: 2035413.41 E: 6003728.36
C10	27.16	103°45'01"	15.00	19.11	STA: 4+89.11 N: 2035413.41 E: 6003728.36	STA: 5+16.27 N: 2035424.54 E: 6003707.54

BERM						
SEGMENT	LENGTH	BEARING/Delta	RADIUS	TANGENT	START	END
L1	74.21	N61°28'05"W			STA: 10+00.00 N: 2035195.97 E: 6003840.71	STA: 10+74.21 N: 2035231.42 E: 6003775.51
C1	29.94	043°13'49"	39.69	15.73	STA: 10+74.21 N: 2035231.42 E: 6003775.51	STA: 11+04.16 N: 2035253.86 E: 6003756.77
L2	117.13	N18°14'16"W			STA: 11+04.16 N: 2035253.86 E: 6003756.77	STA: 12+21.29 N: 2035365.11 E: 6003720.12
C2	28.76	008°14'23"	200.00	14.41	STA: 12+21.29 N: 2035365.11 E: 6003720.12	STA: 12+50.05 N: 2035392.98 E: 6003713.11
L3	81.16	N09°59'53"W			STA: 12+50.05 N: 2035392.98 E: 6003713.11	STA: 13+31.21 N: 2035472.91 E: 6003699.02
L4	68.41	N16°40'05"W			STA: 13+31.21 N: 2035472.91 E: 6003699.02	STA: 13+99.62 N: 2035538.44 E: 6003679.39
C3	16.25	009°18'31"	100.00	8.14	STA: 13+99.62 N: 2035538.44 E: 6003679.39	STA: 14+15.87 N: 2035553.56 E: 6003673.49
L5	197.90	N25°58'36"W			STA: 14+15.87 N: 2035553.56 E: 6003673.49	STA: 16+13.77 N: 2035731.47 E: 6003586.81
L6	128.06	N27°42'18"W			STA: 16+13.77 N: 2035731.47 E: 6003586.81	STA: 17+41.83 N: 2035844.84 E: 6003527.28

S. WETLAND						
SEGMENT	LENGTH	BEARING/Delta	RADIUS	TANGENT	START	END
L12	4.61	N18°13'59"W			STA: 0+00.00 N: 2035361.69 E: 6003724.07	STA: 0+04.61 N: 2035366.07 E: 6003722.96
C11	11.85	084°53'08"	8.00	7.32	STA: 0+04.61 N: 2035366.07 E: 6003722.96	STA: 0+16.47 N: 2035375.92 E: 6003727.39
L13	14.58	N66°39'09"E			STA: 0+16.47 N: 2035375.92 E: 6003727.39	STA: 0+31.04 N: 2035381.69 E: 6003740.77
L14	43.84	N66°39'09"E			STA: 0+31.04 N: 2035381.69 E: 6003740.77	STA: 0+74.89 N: 2035399.07 E: 6003781.03
C12	22.60	012°56'59"	100.00	11.35	STA: 0+74.89 N: 2035399.07 E: 6003781.03	STA: 0+97.49 N: 2035410.28 E: 6003800.59
L15	20.07	N53°42'10"E			STA: 0+97.49 N: 2035410.28 E: 6003800.59	STA: 1+17.56 N: 2035422.16 E: 6003816.77
C13	46.11	066°02'31"	40.00	26.00	STA: 1+17.56 N: 2035422.16 E: 6003816.77	STA: 1+63.66 N: 2035424.66 E: 6003860.29
L16	7.76	S60°15'18"E			STA: 1+63.66 N: 2035424.66 E: 6003860.29	STA: 1+71.42 N: 2035420.81 E: 6003867.03
C14	18.51	053°01'06"	20.00	9.98	STA: 1+71.42 N: 2035420.81 E: 6003867.03	STA: 1+89.93 N: 2035405.96 E: 6003876.94
L17	50.18	S07°14'13"E			STA: 1+89.93 N: 2035405.96 E: 6003876.94	STA: 2+40.11 N: 2035356.18 E: 6003883.27
C15	55.33	031°41'59"	100.00	28.39	STA: 2+40.11 N: 2035356.18 E: 6003883.27	STA: 2+95.44 N: 2035302.17 E: 6003875.09
L18	98.30	S24°27'46"W			STA: 2+95.44 N: 2035302.17 E: 6003875.09	STA: 3+93.74 N: 2035212.69 E: 6003834.38
C16	10.14	083°00'53"	7.00	6.19	STA: 3+93.74 N: 2035212.69 E: 6003834.38	STA: 4+03.88 N: 2035208.91 E: 6003825.90
L19	14.33	N72°31'22"W			STA: 4+03.88 N: 2035208.91 E: 6003825.90	STA: 4+18.21 N: 2035213.22 E: 6003812.24

- NOTES:
- ALL MEASUREMENTS GIVEN ARE IN US FOOT.
  - HORIZONTAL DATUM IS NAD83 CALIFORNIA STATE PLANES ZONE III, US FOOT.
  - VERTICAL DATUM IS NAVD88.


COORDINATE:  
NAD83  
ELEVATION  
DATUM:  
NAVD 1988

95% SUBMITTAL  
  
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OCTOBER 29,  
2010

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PROJECT ENGINEER	CQ	DRAWN	KVS
PROJECT MANAGER	MS	DESIGNED	CQ
APPROVAL	MS	CHECKED	ABW
NO.	DATE	DESCRIPTION	BY
REVISIONS			

<b>CONTRACT NO. WD-2651</b> CITY AND COUNTY OF SAN FRANCISCO <b>PUBLIC UTILITIES COMMISSION</b> INFRASTRUCTURE DIVISION ENGINEERING MANAGEMENT BUREAU			
<b>UPPER SAN MATEO CREEK</b>			
<b>ALIGNMENT AND SURVEY CONTROL PLAN</b>			
CHECKED / APPROVED		DRAWN	SCALE
SECTION MANAGER		DESIGNED	AS SHOWN
APPROVED		DATE	
APPROVED		APPROVED	
MANAGER, ENGINEERING MANAGEMENT BUREAU		MANAGER, NATURAL RESOURCES DIVISION	
SHEET	PLAN NO.	DRAWING NO.	REVISION NO.
<b>4 of 10</b>		<b>C-1</b>	



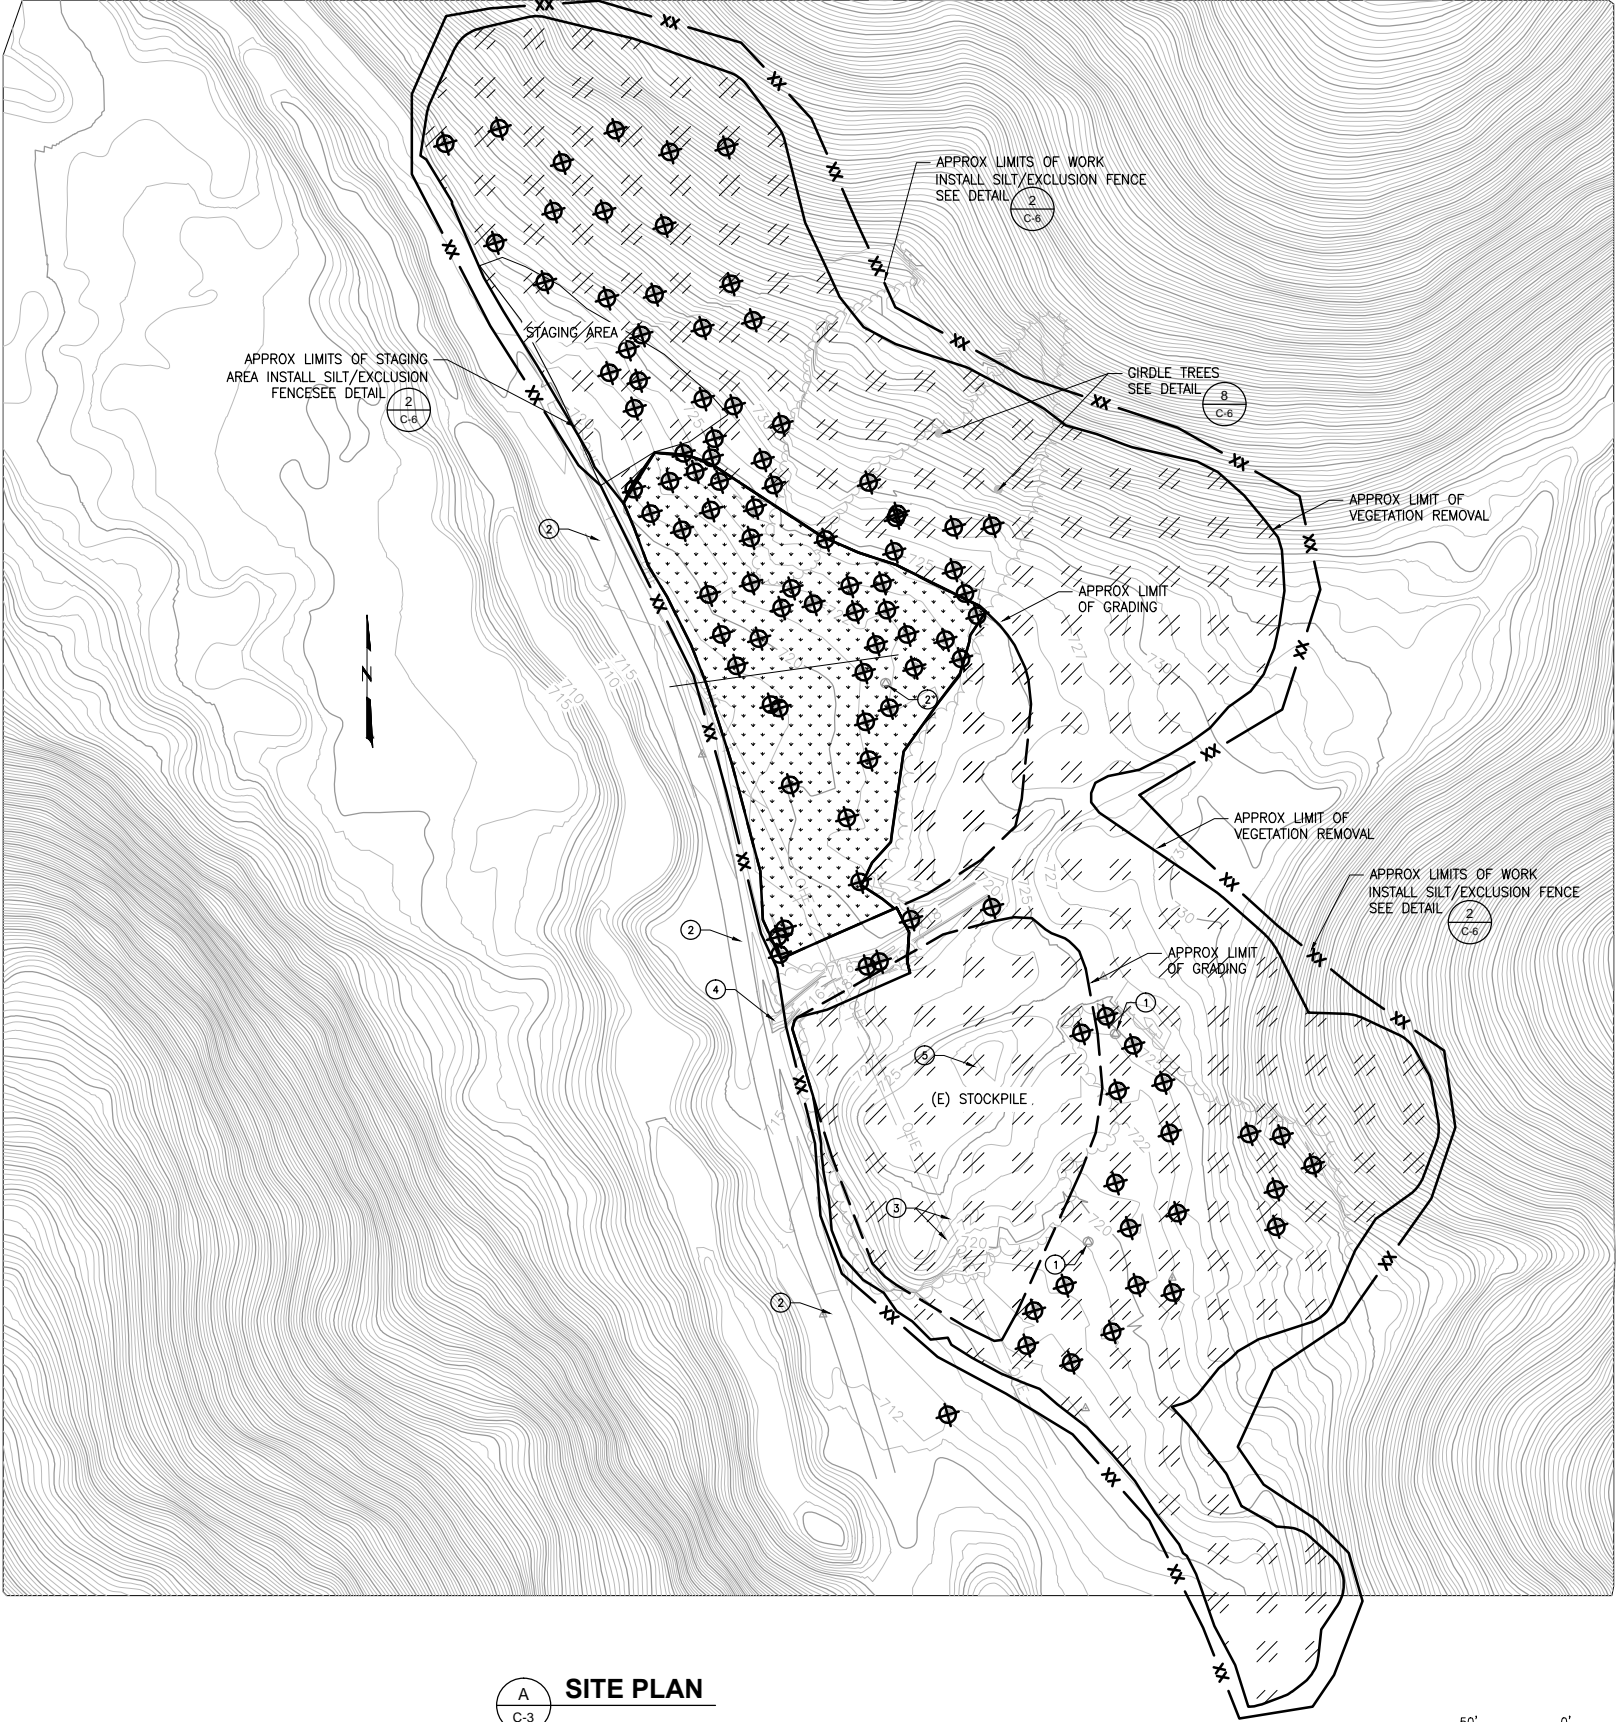

A SITE PLAN  
C-3

ESTIMATED QUANTITIES	
ITEM	ESTIMATED QUANTITY
TREE REMOVAL	120
TREE GIRDLING	2
SCRUB CLEARING	4 AC
TOPSOIL STRIPPING & STOCKPILING*	900 CY
(E) PIEZOMETERS TO ABANDON	3
SILT FENCE	3000 LF

\*QUANTITY BASED ON IN-SITU SOIL VOLUME

KEYNOTES

- ① REMOVE OR ABANDON EXIST PIEZOMETERS
- ② EXIST ASPHALT ROAD TO REMAIN
- ③ EXIST OVERHEAD UTILITY LINES TO REMAIN. CAUTION MUST BE USED WHEN WORKING NEAR THE LINE WITH MACHINERY.
- ④ EXIST 36" CULVERT TO REMAIN
- ⑤ REMOVE EXIST STOCKPILE TO GRADE AND MOVE TO NEW STOCKPILE AREA FOR POTENTIAL TESTING AND RE-USE

LEGEND

- REMOVE EXISTING VEGETATION AND STOCKPILE TOP 6-INCHES OF TOPSOIL
- REMOVE EXISTING THICK SCRUB AND DO NOT SAVE TOPSOIL
- REMOVE EXISTING TREE, TYP ⑤ C-6

NOTES:

1. EXISTING PIEZOMETERS TO BE ABANDONED OR REMOVED ACCORDING TO SAN MATEO COUNTY HEALTH DEPARTMENT ENVIRONMENTAL HEALTH SERVICES DIVISION STANDARDS.
2. WORK AREA TO BE FENCED OFF TO RESTRICT THE ACCESS OF HEAVY EQUIPMENT FROM PROTECTED AREAS DURING GRADING. FENCED AREA TO BE APPROVED BY CITY REPRESENTATIVE BEFORE COMMENCEMENT OF GRADING.
3. PROTECTED TREES TO BE MARKED BY CITY REPRESENTATIVE BEFORE COMMENCEMENT OF GRADING.
4. TREES TO BE REMOVED SHALL BE MARKED BY CITY REPRESENTATIVE BEFORE COMMENCEMENT OF TREE REMOVAL.
5. TREES TO BE GIRDLED SHALL BE MARKED BY CITY REPRESENTATIVE BEFORE COMMENCEMENT OF TREE REMOVAL.
6. TREE LOCATIONS SHOWN MAY NOT BE EXACT. ALL TREES WITHIN THE PROJECT BOUNDARY SHALL BE IDENTIFIED BY CITY REPRESENTATIVE AND MARKED.
7. THE TOPSOIL SHOULD BE OBSERVED AND APPROVED BY CITY REPRESENTATIVE BEFORE STOCKPILING. IF TOPSOIL IS NOT APPROVED FOR USE, IT SHALL BE DISPOSED OF.
8. STOCKPILE AREA SHALL BE IN STAGING AREA.
9. EXACT LOCATION OF SILT/EXCLUSION FENCE TO BE DETERMINED BY CITY REPRESENTATIVE IN THE FIELD.
10. CONTRACTOR MAY SUGGEST AN ALTERNATE LOCATION OF STAGING AREA. THE LOCATION MUST BE APPROVED BY CITY REPRESENTATIVE BEFORE CHANGING LOCATIONS.

CONTRACT NO. WD-2651

CITY AND COUNTY OF SAN FRANCISCO  
PUBLIC UTILITIES COMMISSION  
INFRASTRUCTURE DIVISION  
ENGINEERING MANAGEMENT BUREAU

UPPER SAN MATEO CREEK

EXISTING CONDITION  
AND DEMOLITION PLAN

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PROJECT MANAGER	MS	DESIGNED	CQ
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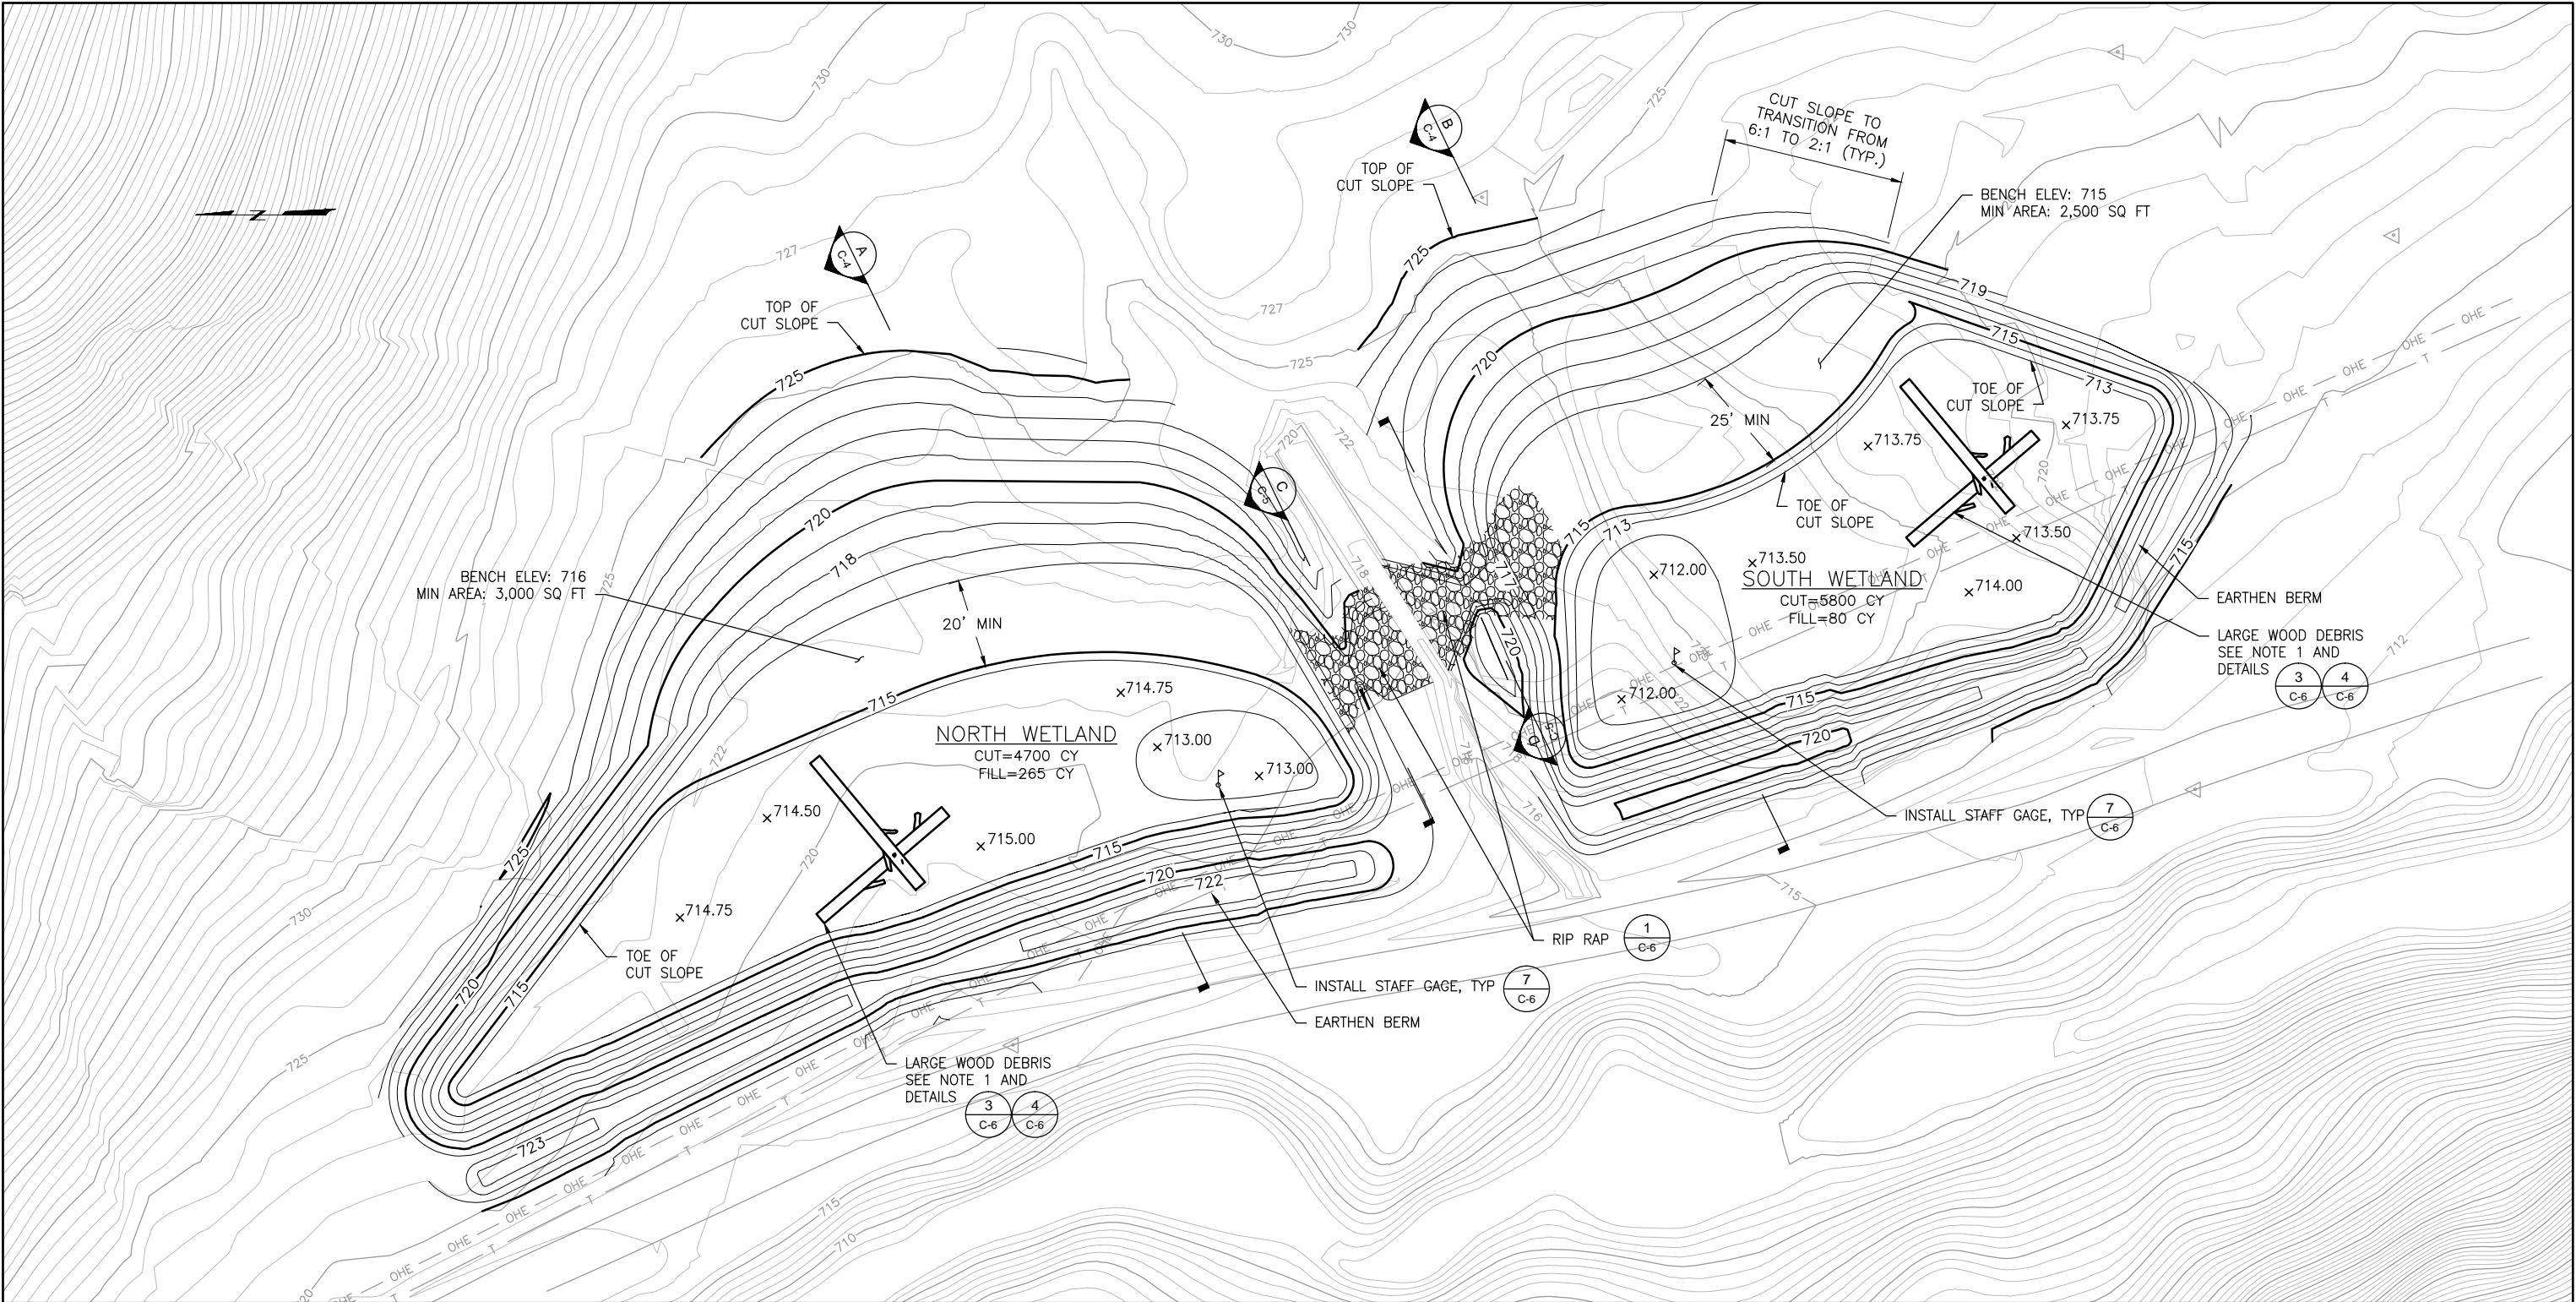
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SECTION MANAGER	DESIGNED	DATE
APPROVED		APPROVED
MANAGER, ENGINEERING MANAGEMENT BUREAU		MANAGER, NATURAL RESOURCES DIVISION
SHEET	PLAN NO.	DRAWING NO.
5 of 10		C-2

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NOT FOR  
CONSTRUCTION

OCTOBER 29,  
2010

COORDINATE:  
NAD83  
ELEVATION  
DATUM:  
NAVD 1988





- NOTES:
1. EXACT LOCATION OF LARGE WOOD DEBRIS SHALL BE DETERMINED IN THE FIELD BY CITY REPRESENTATIVE.
  2. BOTTOM OF WETLAND SHALL INCLUDE MICRO-TOPOGRAPHY AS REPRESENTED BY PROPOSED SPOT ELEVATIONS. THE SPOT ELEVATIONS REPRESENT HIGH POINTS WITHIN THE MICRO-TOPOGRAPHY. LOCATION AND ELEVATION IS APPROXIMATE AND SHOULD BE APPROVED BY CITY REPRESENTATIVE.
  3. BOTTOM OF WETLAND SHALL BE COMPACTED ACCORDING TO SPECIFICATIONS
  4. CONTRACTOR SHALL AVOID THE OVERHEAD LINE.

ESTIMATED QUANTITIES	
ITEM	ESTIMATED QUANTITY
TOTAL WETLANDS CUT*	10,500 CY
TOTAL WETLANDS FILL	345 CY
LARGE WOODY DEBRIS	4
FINISH GRADING	55,000 SQ FT
STAFF GAGE	2
RIP RAP	180 CY

\* QUANTITY BASED ON IN-SITU SOIL VOLUME.

**WETLAND GRADING PLAN**

1" = 20'

COORDINATE:  
NAD83  
ELEVATION  
DATUM:  
NAVD 1988

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2010

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PROJECT MANAGER	MS	DESIGNED	CQ
APPROVAL	MS	CHECKED	ABW
NO.	DATE	DESCRIPTION	BY APPR'D
REVISIONS			


CONTRACT NO. WD-2651

CITY AND COUNTY OF SAN FRANCISCO  
**PUBLIC UTILITIES COMMISSION**  
INFRASTRUCTURE DIVISION  
ENGINEERING MANAGEMENT BUREAU

**UPPER SAN MATEO CREEK**


**WETLAND GRADING PLAN**

CHECKED / APPROVED	DRAWN	SCALE AS SHOWN
SECTION MANAGER	DESIGNED	DATE
APPROVED	APPROVED	
MANAGER, ENGINEERING MANAGEMENT BUREAU	MANAGER, NATURAL RESOURCES DIVISION	
SHEET	PLAN NO.	DRAWING NO.
6 OF 10		C-3

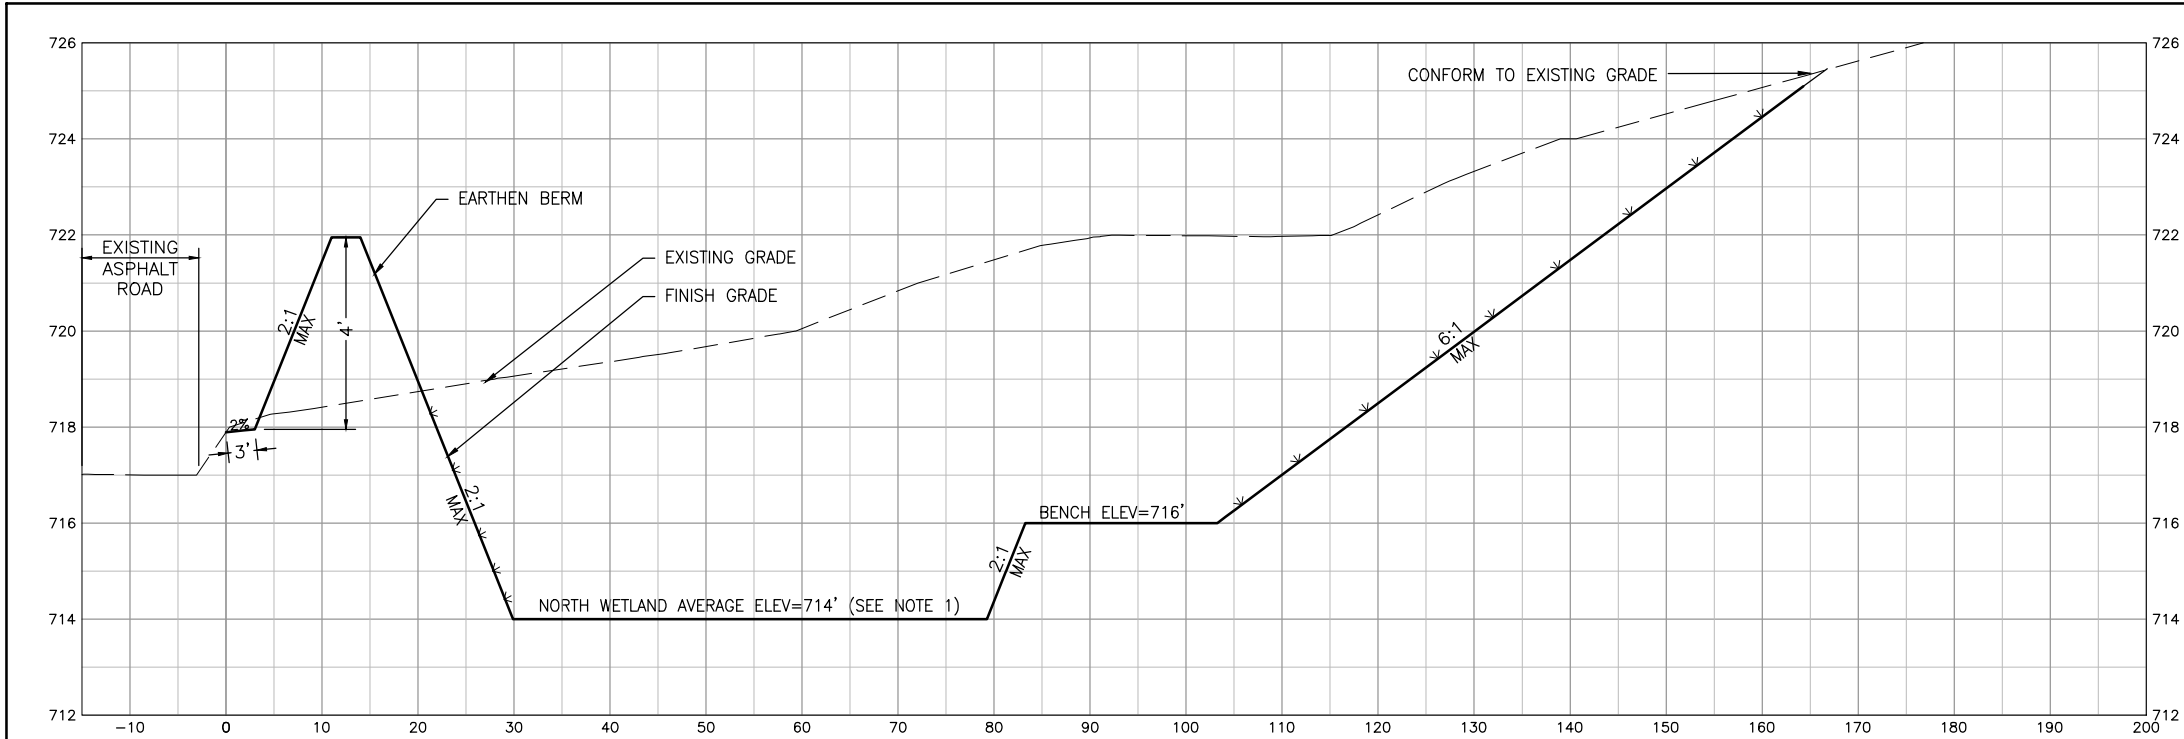

**A**  
C-3 **NORTH WETLAND - SECTION**  
SCALE: 1"=10'H 1"=2'V

- NOTES:
1. THE BOTTOM SURFACE OF THE WETLAND SHALL NOT BE EXACTLY FLAT. THE SURFACE SHALL VARY IN ELEVATION  $\pm 1'$  FROM THE AVERAGE ELEVATION SHOWN.
  2. CONTRACTOR SHALL AVOID OVERHEAD LINE.

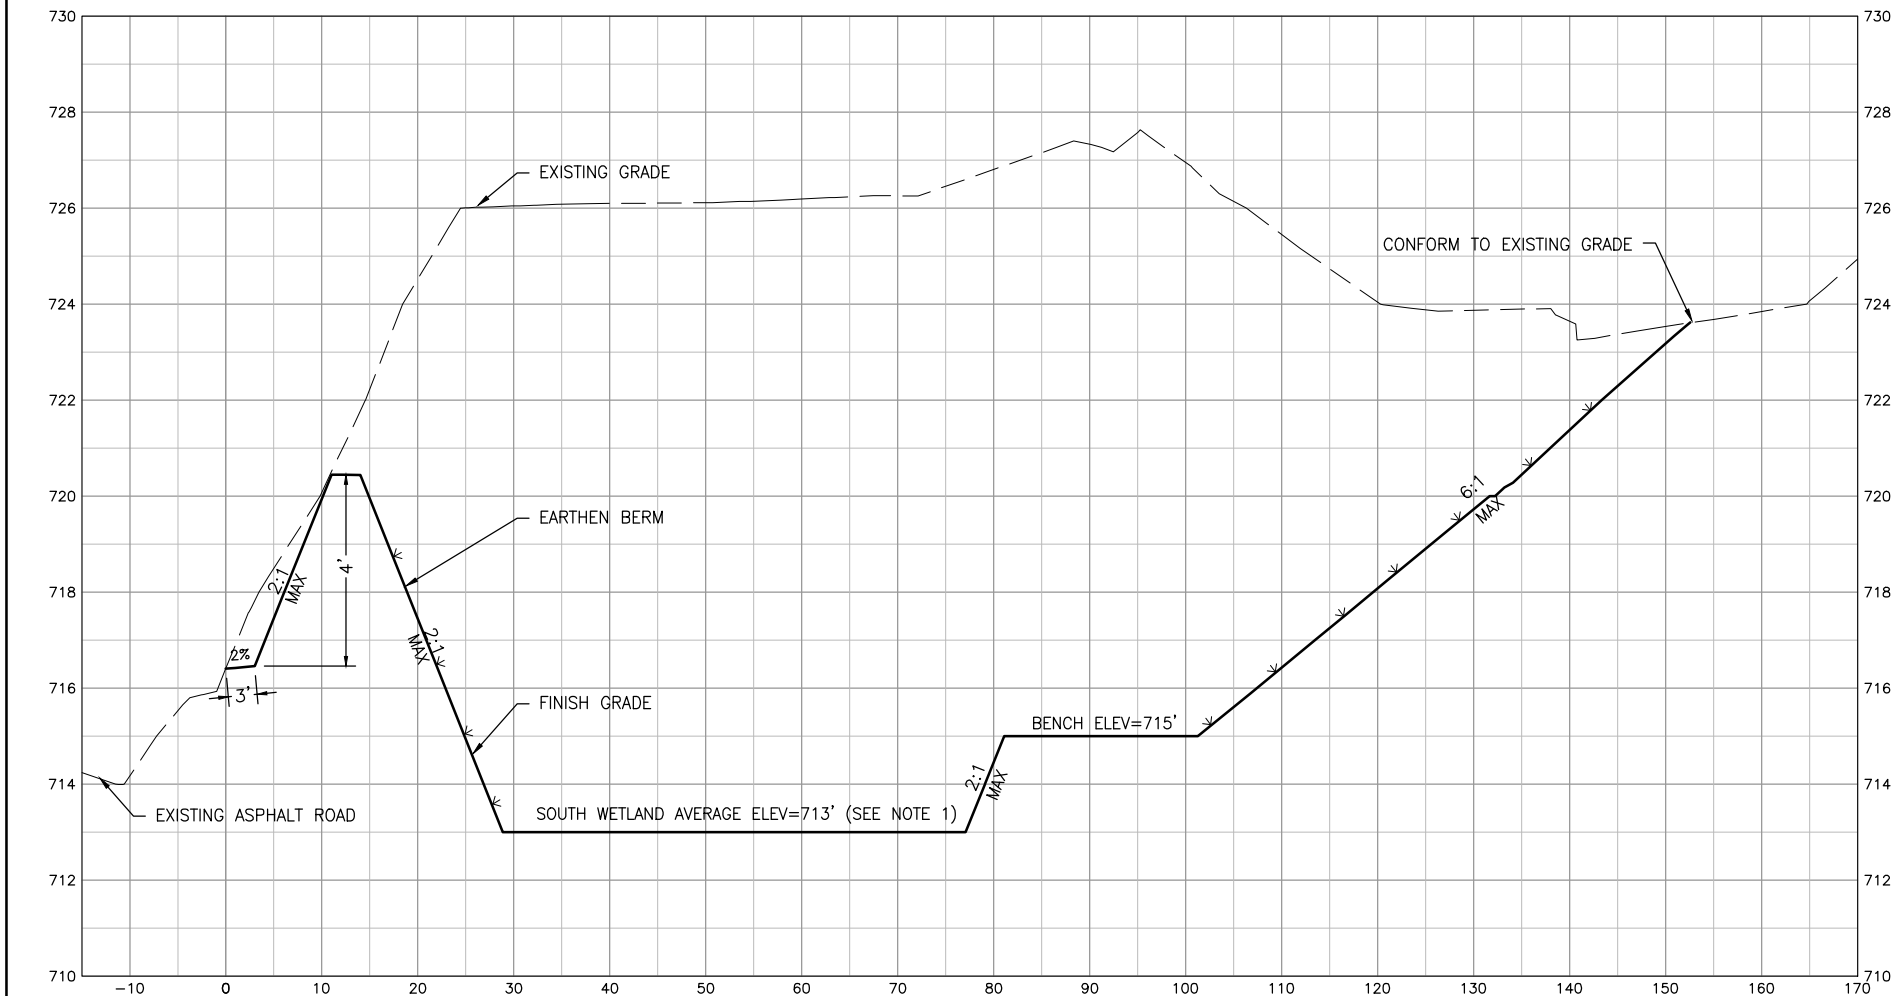

**B**  
C-3 **SOUTH WETLAND - SECTION**  
SCALE: 1"=10'H 1"=2'V




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DATUM:  
NAVD 1988


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PROJECT ENGINEER	CQ	DRAWN	KVS
PROJECT MANAGER	MS	DESIGNED	CQ
APPROVAL	MS	CHECKED	ABW
NO.	DATE	DESCRIPTION	BY
REVISIONS			

CONTRACT NO. WD-2651		
CITY AND COUNTY OF SAN FRANCISCO PUBLIC UTILITIES COMMISSION INFRASTRUCTURE DIVISION ENGINEERING MANAGEMENT BUREAU		
UPPER SAN MATEO CREEK		
WETLAND SECTIONS		
CHECKED / APPROVED	DRAWN	SCALE AS SHOWN
SECTION MANAGER	DESIGNED	DATE
APPROVED	APPROVED	
MANAGER, ENGINEERING MANAGEMENT BUREAU	MANAGER, NATURAL RESOURCES DIVISION	
SHEET	PLAN NO.	DRAWING NO.
7 of 10		C-4

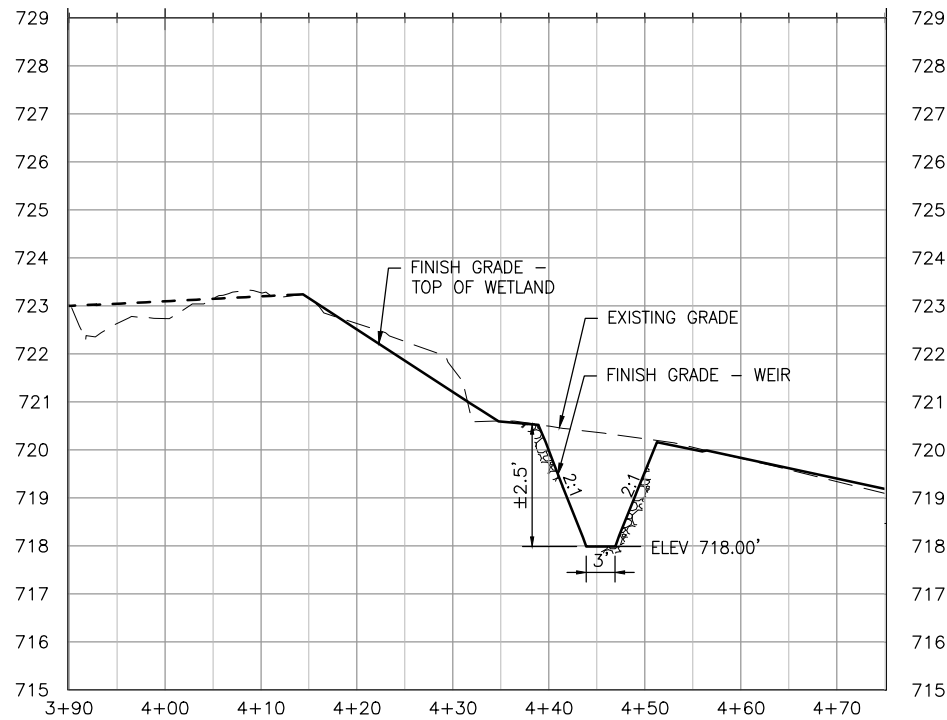

**C**  
C-3 **NORTH WETLAND - OUTFLOW WEIR PROFILE**  
SCALE: 1"=10'H 1"=2'V

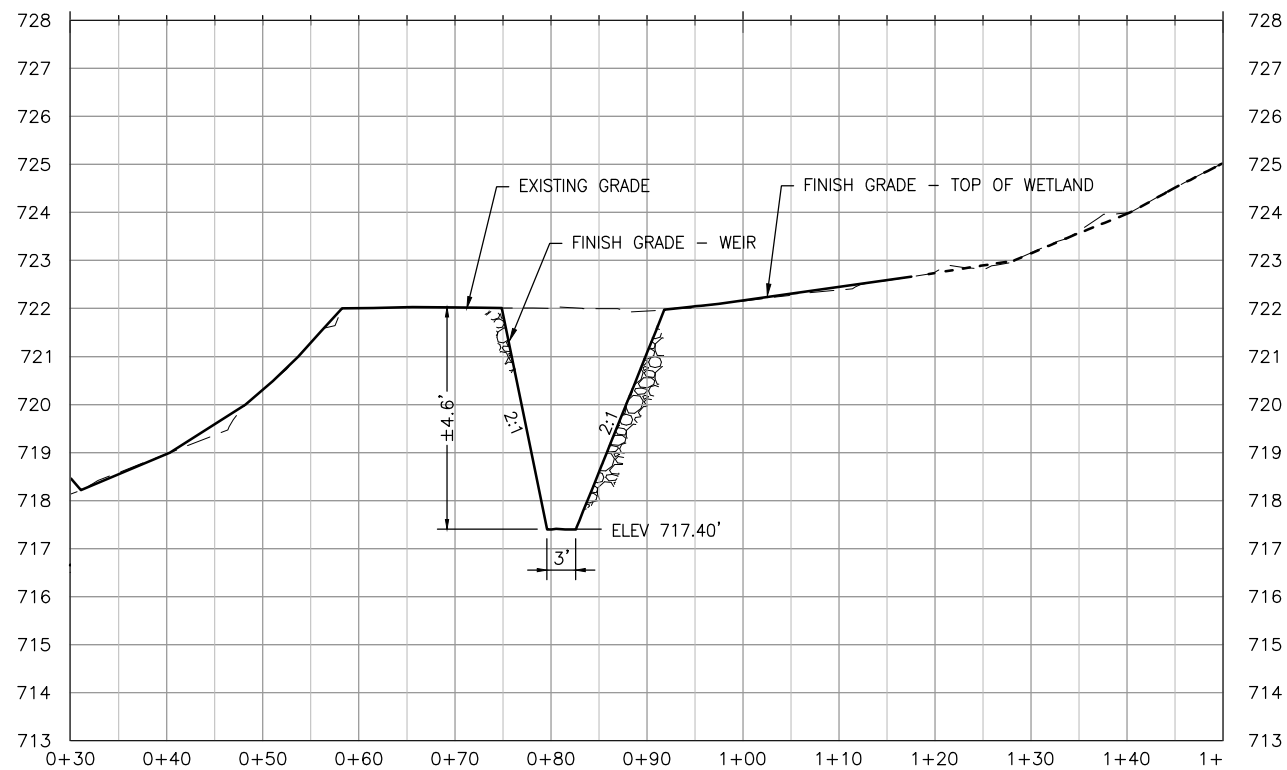

**D**  
C-3 **SOUTH WETLAND - INFLOW/OUTFLOW WEIR PROFILE**  
SCALE: 1"=10'H 1"=2'V

- NOTES:
- CONTRACTOR SHALL AVOID OVERHEAD LINE.

CONTRACT NO. WD-2651

CITY AND COUNTY OF SAN FRANCISCO  
**PUBLIC UTILITIES COMMISSION**  
INFRASTRUCTURE DIVISION  
ENGINEERING MANAGEMENT BUREAU

**UPPER SAN MATEO CREEK**

**WETLAND SECTIONS**

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PROJECT ENGINEER		CQ	DRAWN		KVS
PROJECT MANAGER		MS	DESIGNED		CQ
APPROVAL		MS	CHECKED		ABW
NO.	DATE	DESCRIPTION			BY
REVISIONS					



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SECTION MANAGER		DESIGNED	DATE
APPROVED		APPROVED	
MANAGER, ENGINEERING MANAGEMENT BUREAU		MANAGER, NATURAL RESOURCES DIVISION	
SHEET	PLAN NO.	DRAWING NO.	REVISION NO.
8 of 10		C-5	

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OCTOBER 29, 2010


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NAD83  
ELEVATION  
DATUM:  
NAVD 1988






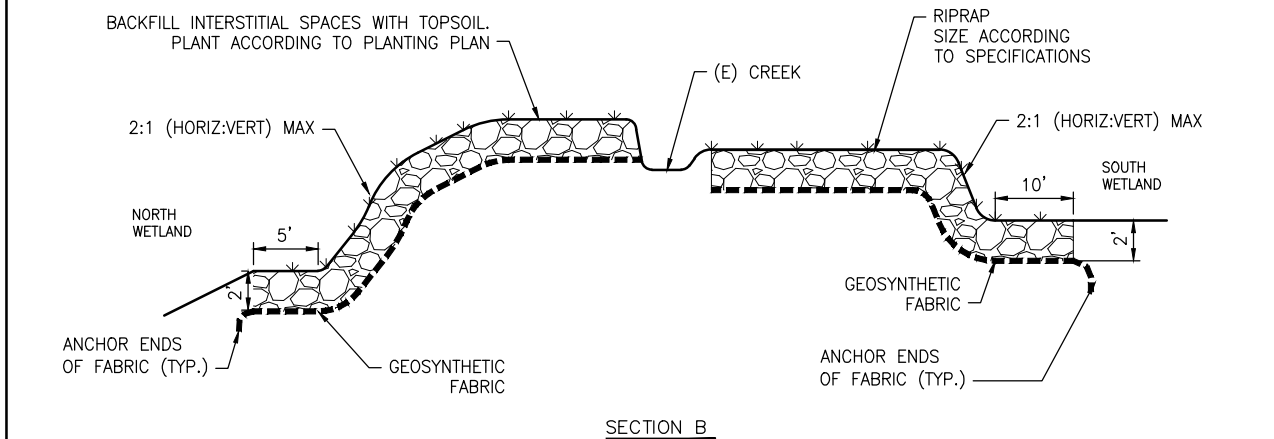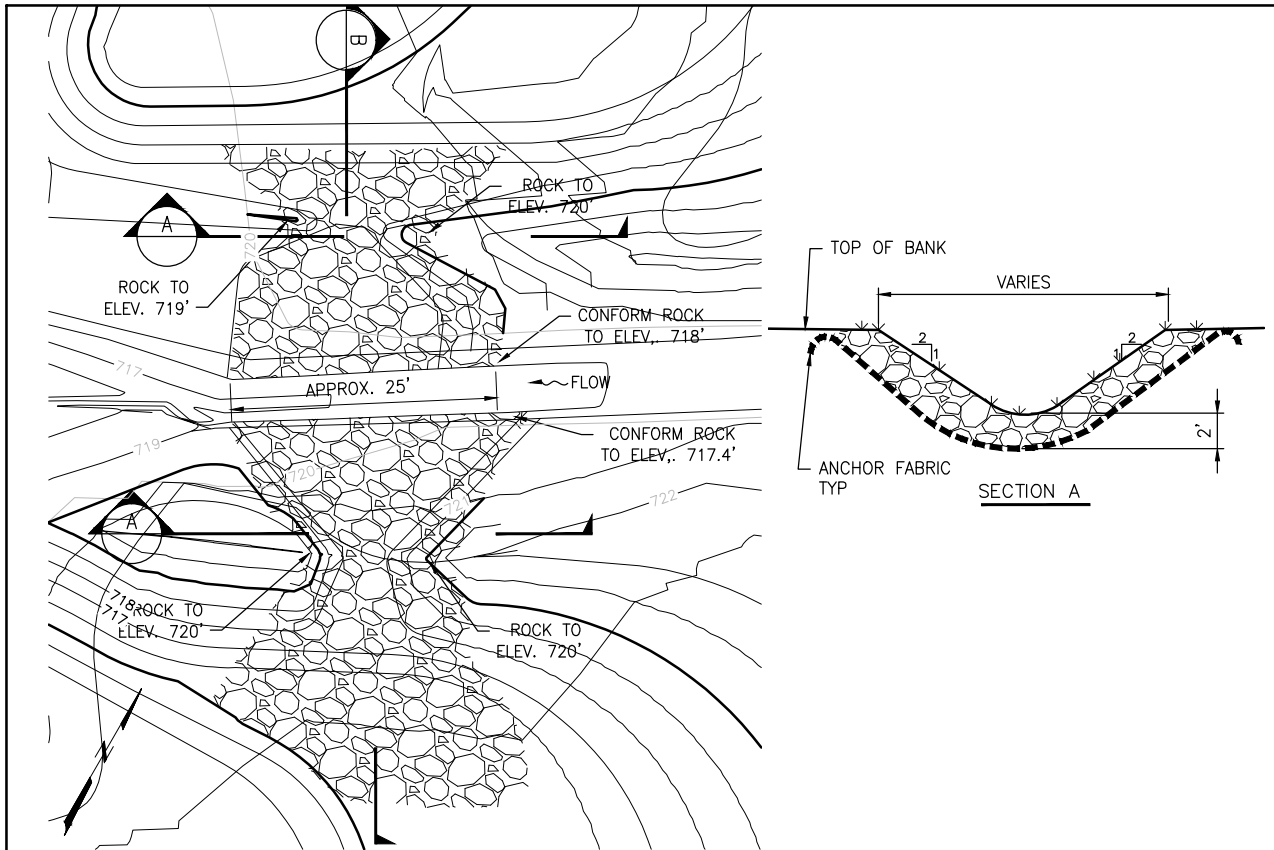


1 WEIR ROCK PROTECTION DETAIL  
C-5 N.T.S.

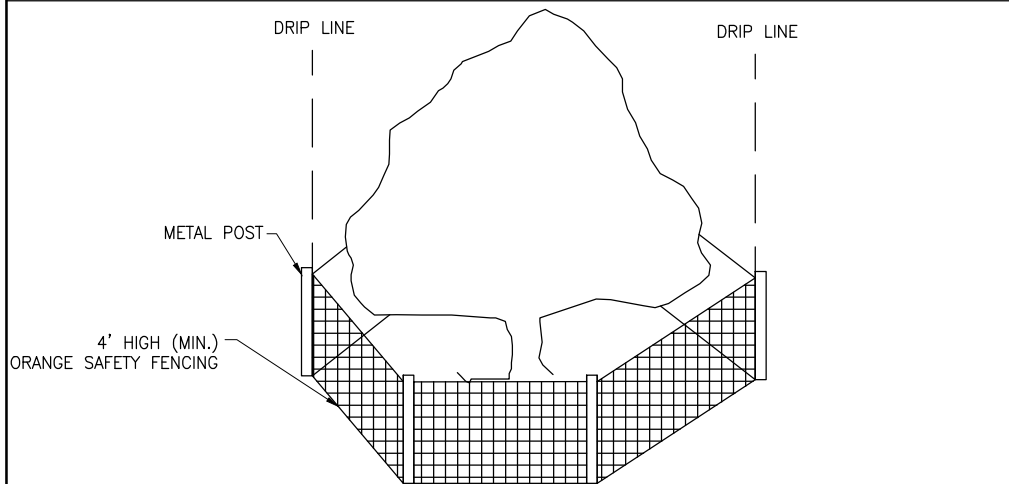


6 TEMPORARY VEGETATION PROTECTION FENCING  
C-2 N.T.S.

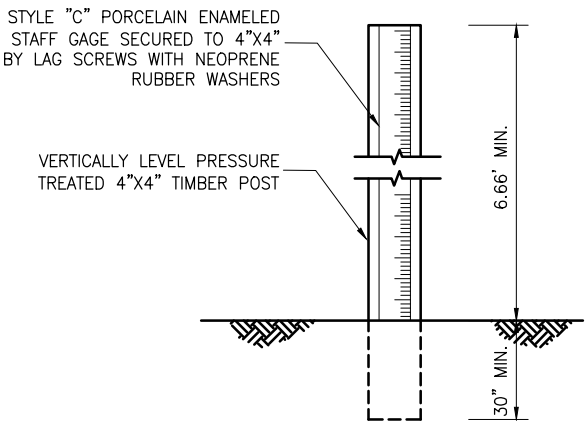

7 STAFF GAGE DETAIL  
C-3 N.T.S.

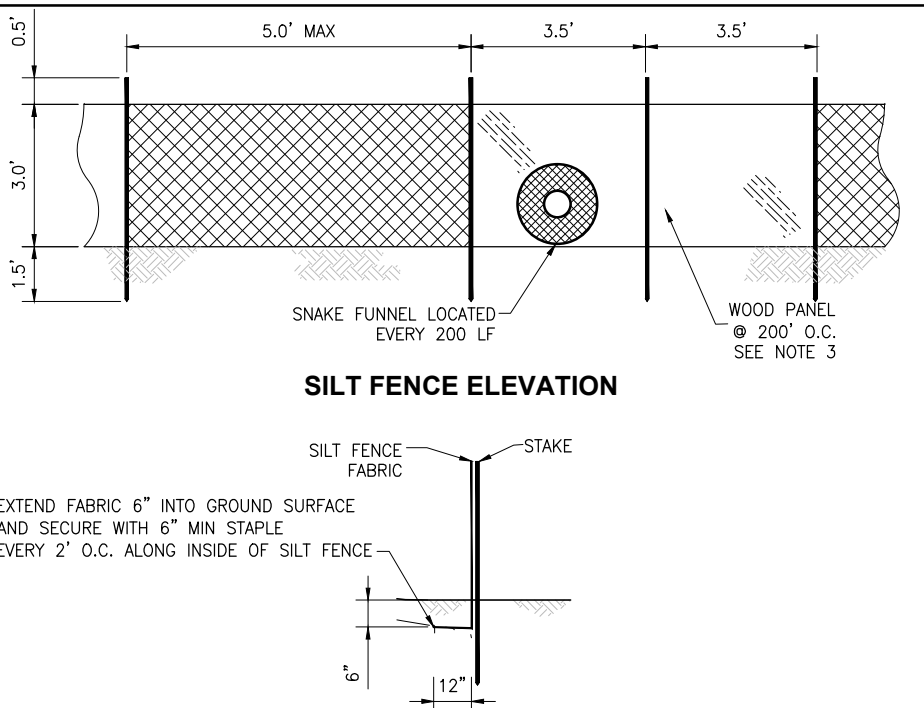

SILT FENCE SECTION

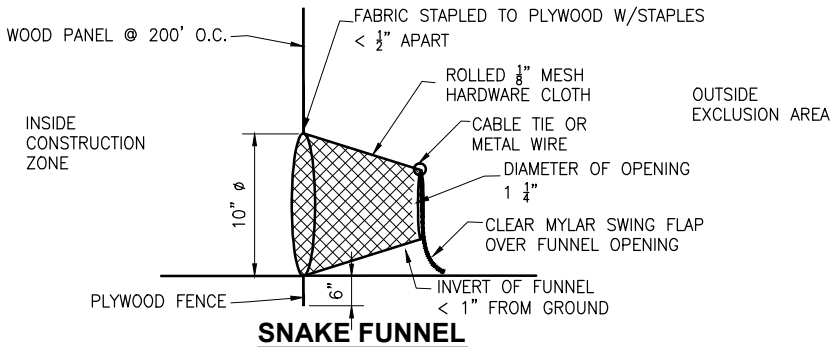


SNAKE FUNNEL

NOTES:

- AT JOINTS, OVERLAP STAKES AND FOLD FENCE FABRIC AROUND EACH STAKE ONE FULL TURN, REFER TO TEMPORARY SILT FENCE POST AT JOINT DETAIL.
- FOR END STAKE CONDITION FOLD FENCE FABRIC AROUND TWO STAKES ONE FULL TURN AND SECURE WITH FOUR STAPLES, REFER TO TEMPORARY SILT FENCE END POST DETAIL.
- SNAKE FUNNEL WITH WOOD PANEL FENCE SHALL BE EVERY 200' O.C. THE WOOD PANEL IS MADE OF 4'X8' HARDWOOD OR PLYWOOD (EXTERIOR GRADE). THE SURFACE SHALL BE FREE OF KNOTS, CRACKS AND HOLES.

2 SILT FENCE/EXCLUSION FENCE INSTALLATION DETAIL  
C-2 N.T.S.

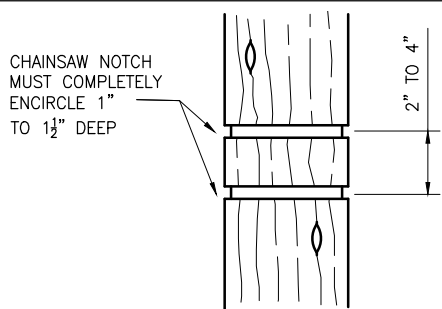


8 TREE GIRDLING DETAIL  
C-2 N.T.S.


COORDINATE:  
NAD83  
ELEVATION  
DATUM:  
NAVD 1988

95% SUBMITTAL  
NOT FOR CONSTRUCTION  
OCTOBER 29, 2010


WINZLER & KELLY			
417 Montgomery Street, Suite 700, San Francisco, CA 94104-1115 tel 415.283.4970 \$ fax 415.283.4980 \$ www.w-and-k.com			
PROJECT ENGINEER	CQ	DRAWN	MLK
PROJECT MANAGER	MS	DESIGNED	CQ
APPROVAL	MS	CHECKED	ABW
NO. DATE DESCRIPTION BY APP'D			
REVISIONS			

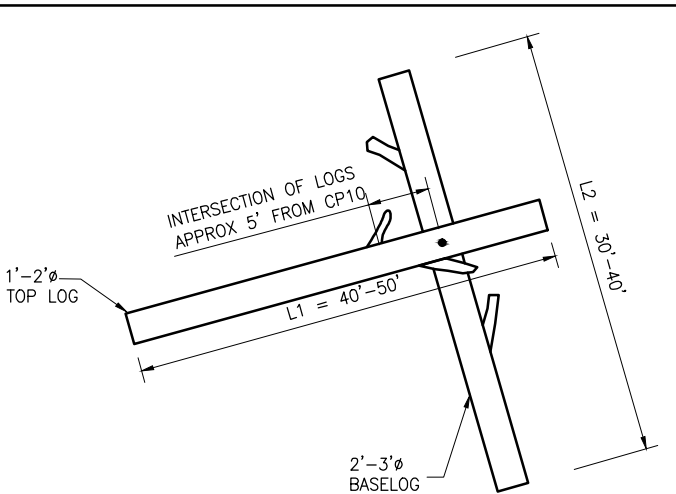

3 LARGE WOODY DEBRIS PLAN  
C-3 N.T.S.

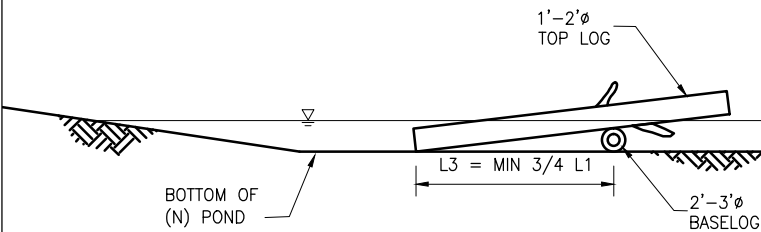

4 LARGE WOODY DEBRIS PROFILE  
C-3 N.T.S.

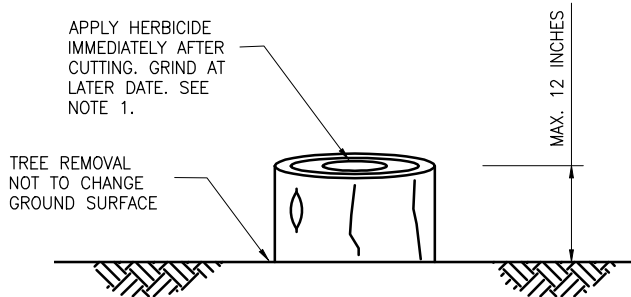

5 TREE REMOVAL DETAIL  
C-2 N.T.S.

NOTES:

- TREES WITHIN AREA TO BE GRADED SHALL BE FULLY REMOVED INCLUDING ROOTBALL.

CONTRACT NO. WD-2651

CITY AND COUNTY OF SAN FRANCISCO  
PUBLIC UTILITIES COMMISSION  
INFRASTRUCTURE DIVISION  
ENGINEERING MANAGEMENT BUREAU

UPPER SAN MATEO CREEK

CONSTRUCTION DETAILS

CHECKED / APPROVED	DRAWN	SCALE AS SHOWN
SECTION MANAGER	DESIGNED	DATE
APPROVED	APPROVED	
MANAGER, ENGINEERING MANAGEMENT BUREAU	MANAGER, NATURAL RESOURCES DIVISION	REVISION NO.
SHEET 9 OF 10	PLAN NO.	C-6



PLANTING DATA		
PLANTING ZONE	PLANTING	ACRES
A	NEEDLEGRASS ESTABLISHMENT	2.97
B	WETLAND ESTABLISHMENT	0.85
A+B	WETLAND/NEEDLEGRASS ECOTONE	0.28
C	EROSION CONTROL	0.27

QUANTITIES		
SCIENTIFIC NAME	COMMON NAME	QUANTITY
SALIX LASIOLEPIS	ARROYO WILLOW	493
SCIRPUS ACUTUS	BULRUSH	275
JUNCUS EFFUSUS	COMMON RUSH	275
JUNCUS PATENS	SPREADING RUSH	275
CAREX BARBARAE	SANTA BARBARA SEDGE	275
ELEOCHARIS MACROSTACHY	COMMON SPIKERUSH	275
BROMUS CARINATUS	CALIFORNIA BROME	32 LBS
DANTHONIA CALIFORNICA	CALIFORNIA OATGRASS	17 LBS
ELYMUS GLAUCUS	BLUE WILDRYE	32 LBS
NASELLA PULCHRA	PURPLE NEEDLEGRASS	17 LBS
VULPIA MICROSTACHYS	THREE WEEK FESCUE	10 LBS
FESTUCA RUBRA	RED FESCUE	2.5 LBS
LUPINUS BICOLOR	BICOLOR LUPINE	8 LBS
ERIOGONUM LATIFOLIUM	COAST BUCKWHEAT	150
LUPINUS ALBIFRONS	SILVERLEAF LUPINE	150

- NOTES:
- TREES TO REMAIN SHALL BE MARKED BY A BIOLOGIST DESIGNATED BY THE CITY REPRESENTATIVE AND PROTECTED.
  - PLANTING ZONE MIXES ARE LOCATED IN THE SPECIFICATIONS.
  - RESTORE STAGING AREA TO ZONE 1 PLANTING.

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PUBLIC UTILITIES COMMISSION  
INFRASTRUCTURE DIVISION  
ENGINEERING MANAGEMENT BUREAU

UPPER SAN MATEO CREEK

PLANTING PLAN

CHECKED / APPROVED

DRAWN

SCALE AS SHOWN

SECTION MANAGER

DESIGNED

DATE

APPROVED

APPROVED

MANAGER, ENGINEERING MANAGEMENT BUREAU

MANAGER, NATURAL RESOURCES DIVISION

10 of 10

PLAN NO.

DRAWING NO.

REVISION NO.

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PROJECT ENGINEER CQ

DRAWN MLK

PROJECT MANAGER MS

DESIGNED CQ

APPROVAL MS

CHECKED ABW

NO.

DATE

DESCRIPTION

BY

APPR'D

REVISIONS

95% SUBMITTAL

NOT FOR CONSTRUCTION

OCTOBER 29, 2010

COORDINATE: NAD83  
ELEVATION DATUM: NAVD 1988

